ALL DIMENSIONS SHOWN ARE TO THE FACE OF STUDS UNLESS OTHERWISE NOTED. SUBCONTRACTORS ARE TO VERIFY ALL INFORMATION ON DRAWINGS PERTAINING TO THEIR AREA OF WORK, ANY DISCREPENCIES FOUND OR FURTHER INFORMATION REQUIRED IS TO BE REPORTED TO THE BUILDER BEFORE COMMENCEMENT OF WORK. THE DESIGNER IS TO BE NOTIFIED OF THESE ITEMS AS WELL, BEFORE THE WORK IN QUESTION IS UNDERTAKEN IF FURTHER INFORMATION IS NECESSARY. 3. ALL EXTERIOR WALLS ARE 2X6'S @ 16" O.C. ALL INTERIOR WALLS ARE 2X4'S @ 16" O.C. UNLESS OTHERWISE NOTED FOR PLUMBING and / or HEATING WALLS. 4. ALL INTERIOR PASSAGE DOOR R.O.'S TO BE 2 1/2" HIGHER AND 2" WIDER THAN ACTUAL DOOR SIZE. 5. ALL BIFOLD DOOR R.O.'S TO BE 1 1/4" WIDER THAN DOOR WIDTH AND 81 1/2" HIGH. 6. BY-PASS DOOR R.O.'S TO BE SAME AS PASSAGE 6. BY-PASS DOOR R.O.'S TO BE SAME AS PASSAGE DOOR OPENINGS. 7. PROVIDE SOLID BACKING TO SUIT IN BATHROOM WALLS FOR INSTALLATION OF TOWEL BARS, @ 40" A.F.F. 8. PROVIDE SOLID BACKING AT STAIRWAYS FOR INSTALLATION OF HAND RAILS @ 36" ABOVE NOSINGS. 9. ALL LINTELS ARE 2-2X10 UNLESS OTHERWISE NOTED. 10. PROVIDE PLYWD. SQUASH BLOCKS IN FLOOR JOIST WEBS AT EXTERIOR WALLS AND INTERIOR LOAD BEARING WALL LOCATIONS IF REQ'D. BY JOIST MFG. 11. SMOKE ALARMS SHALL BE HARD-WIRED, INTERCONNECTED 84'-0" AND LOCATED ON EVERY FLOOR LEVEL, INCLUDING BASEMENT; WITHIN 16' OF EACH BEDROOM DOOR; AND WITHIN 50' OF ANY 42'-0" 42'-0" POINT ON A FLOOR AREA. 10'-5 3/4" 5'-4" 52'-4 1/2" 5'-4" 10'-5 3/4" BRIAN L. MANSKY CT (ARCH) CRAWL SPACE ACCESS / UTILITIES CRAWL SPACE ACCESS / UTILITIES DINING ROOM KITCHEN KITCHEN DINING ROOM VENTILATION BULKHEAD 200-1200 Pembina Hwy. Winnipeg MB R3T 2A7 3068 28'-(I.)_ 287-8580 FAX 475-3859 2-1 3/4" × 14" FLUSH LVL HEADER 2-2668 2-2668 **CARRINGTON HOMES** BEDROOM MASTER BORM MASTER BORM BEDROOM 798-2100 LIVING ROOM LIVING ROOM PROJECT 4 UNIT 3-2×10 *2 SPF LINTEL 2 3-2×10 *2 SPF LINTEL **CONDOMINIUM** 96 s.f. 96 s.f. STORAGE STORAGE SHEET TITLE PORCH PORCH 3-2×10*2 SPF HEADER 3-2×10*2 5PF HEADER MAIN FLOOR PLAN DRAWN BY SCALE MAIN FLOOR PLAN PLAN NOTES: 1/8" = 1' - 0" BLM T.A 1. 2-2×8 *2 SPF POST, THESE POSTS ALIGN WITH CONCRETE PILES BELOW. DATE SHEET NO. 2. PROVIDE 3 PLY 2 \times 6 *2 SPF POST EA, SIDE TO SUIT AT EACH 3 PLY LINTEL. 22 NOV 2010

GENERAL NOTES:

84'-0" 42'-0" 42'-0" WH LOWER DINING ROOM DINING ROOM KITCHEN KITCHEN 2-2668 MASTER BORM MASTER BDRM BEDROOM LIVING ROOM LIVING ROOM BEDROOM PORCH PORCH STORAGE STORAGE SECOND FLOOR PLAN

GENERAL NOTES:

1. ALL DIMENSIONS SHOWN ARE TO THE FACE OF STUDS

POINT ON A FLOOR AREA.

UNLESS OTHERWISE NOTED.

2. SUBCONTRACTORS ARE TO VERIFY ALL INFORMATION ON DRAWINGS PERTAINING TO THEIR AREA OF WORK, ANY DISCREPENCIES FOUND OR FURTHER INFORMATION REQUIRED IS TO BE REPORTED TO THE BUILDER BEFORE COMMENCEMENT OF WORK. THE DESIGNER IS TO BE NOTIFIED OF THESE ITEMS AS WELL, BEFORE THE WORK IN QUESTION IS UNDERTAKEN IF FURTHER INFORMATION IS NECESSARY.

- 3. ALL EXTERIOR WALLS ARE 2X6'S @ 16" O.C. ALL INTERIOR WALLS ARE 2X4'S @ 16" O.C. UNLESS OTHERWISE NOTED FOR PLUMBING and / or
- HEATING WALLS.

 4. ALL INTERIOR PASSAGE DOOR R.O.'S TO BE 2 1/2" HIGHER AND 2" WIDER THAN ACTUAL DOOR SIZE.

 5. ALL BIFOLD DOOR R.O.'S TO BE 1 1/4" WIDER THAN DOOR
- WIDTH AND 81 1/2" HIGH.
- 6. BY-PASS DOOR R.O.'S TO BE SAME AS PASSAGE DOOR OPENINGS.


- DOOR OPENINGS.

 7. PROVIDE SOLID BACKING TO SUIT IN BATHROOM WALLS FOR INSTALLATION OF TOWEL BARS, @ 40" A.F.F.

 8. PROVIDE SOLID BACKING AT STAIRWAYS FOR INSTALLATION OF HAND RAILS @ 36" ABOVE NOSINGS.

 9. ALL LINTELS ARE 2-2X10 UNLESS OTHERWISE NOTED.

 10. PROVIDE PLYWD. SQUASH BLOCKS IN FLOOR JOIST WEBS AT EXTERIOR WALLS AND INTERIOR LOAD BEARING
- WALL LOCATIONS IF REQ'D. BY JOIST MFG. 11. SMOKE ALARMS SHALL BE HARD-WIRED, INTERCONNECTED AND LOCATED ON EVERY FLOOR LEVEL, INCLUDING BASEMEN' WITHIN 16' OF EACH BEDROOM DOOR; AND WITHIN 50' OF ANY

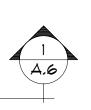





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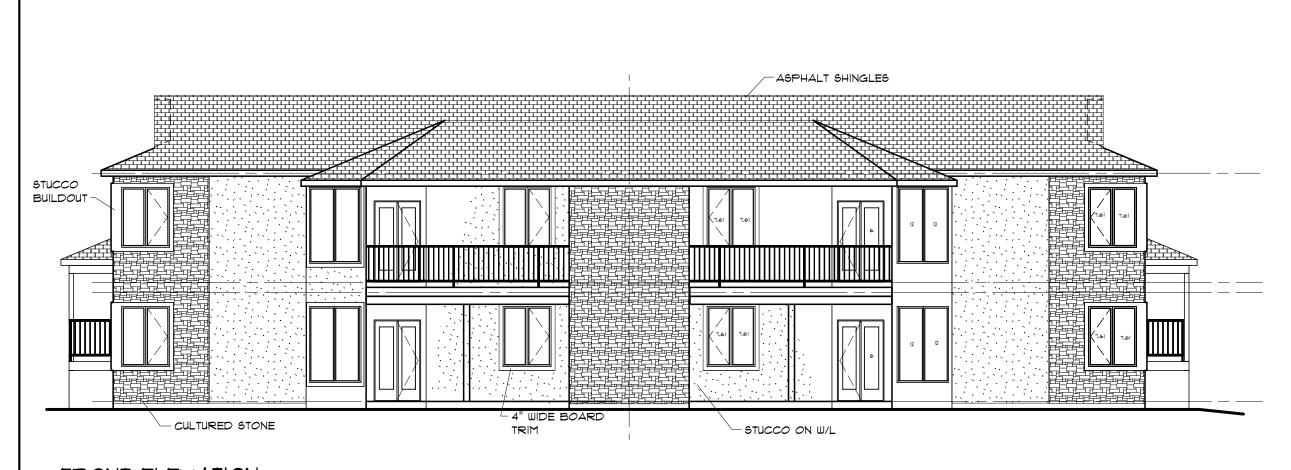
4 UNIT **CONDOMINIUM**

SECOND FLOOR PLAN


SCALE 1/8" DATE

DRAWN BY BLM SHEET NO.

22 NOV 2010



FRONT ELEVATION

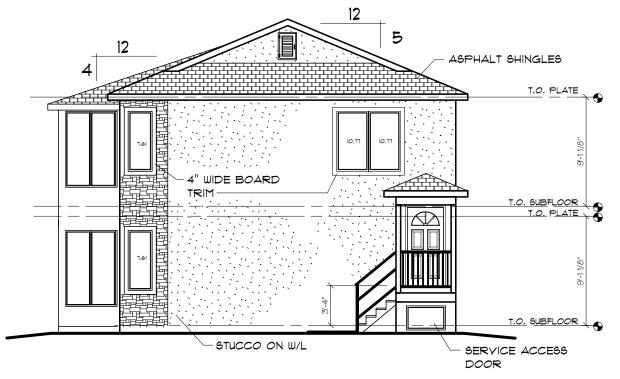

200-1200 Pembina Hwy. Winnipeg MB R3T 2A7

CARRINGTON HOMES 798-2100

PROJECT

4 UNIT **CONDOMINIUM**

SHEET TITLE


ELEVATIONS

1/8" = 1' - 0"


DRAWN BY BLM SHEET NO.

22 NOY 2010

RIGHT ELEVATION

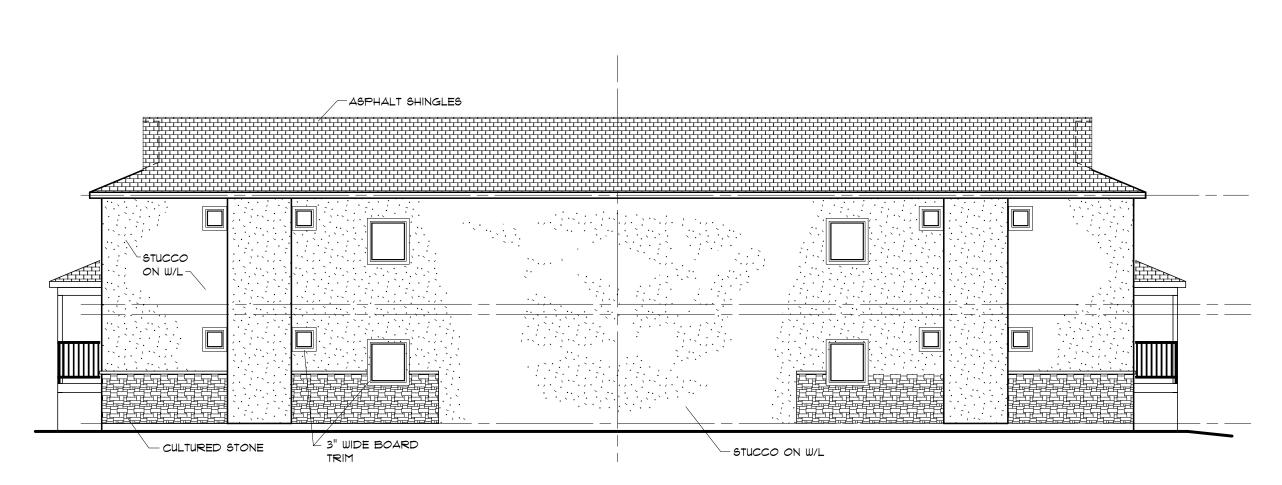

REAR ELEVATION

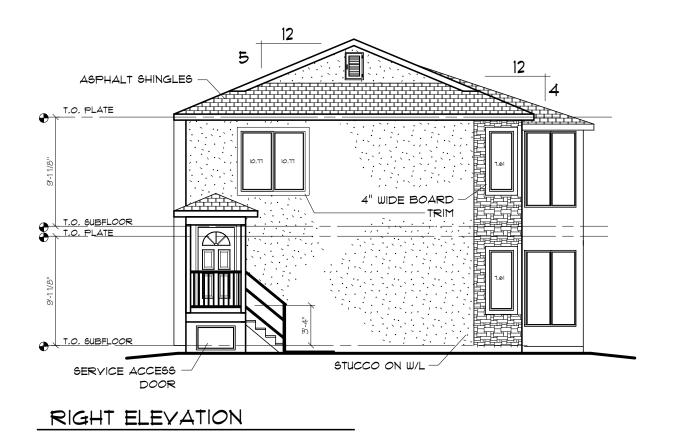

SHEET TITLE

PROJECT

REAR & RIGHT ELEVATIONS

CARRINGTON

HOMES 798-2100

4 UNIT

CONDOMINIUM


SCALE 1/8" = 1' - 0" BLM
SHEET NO.

A.5

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22 NOV 2010

DY 2010

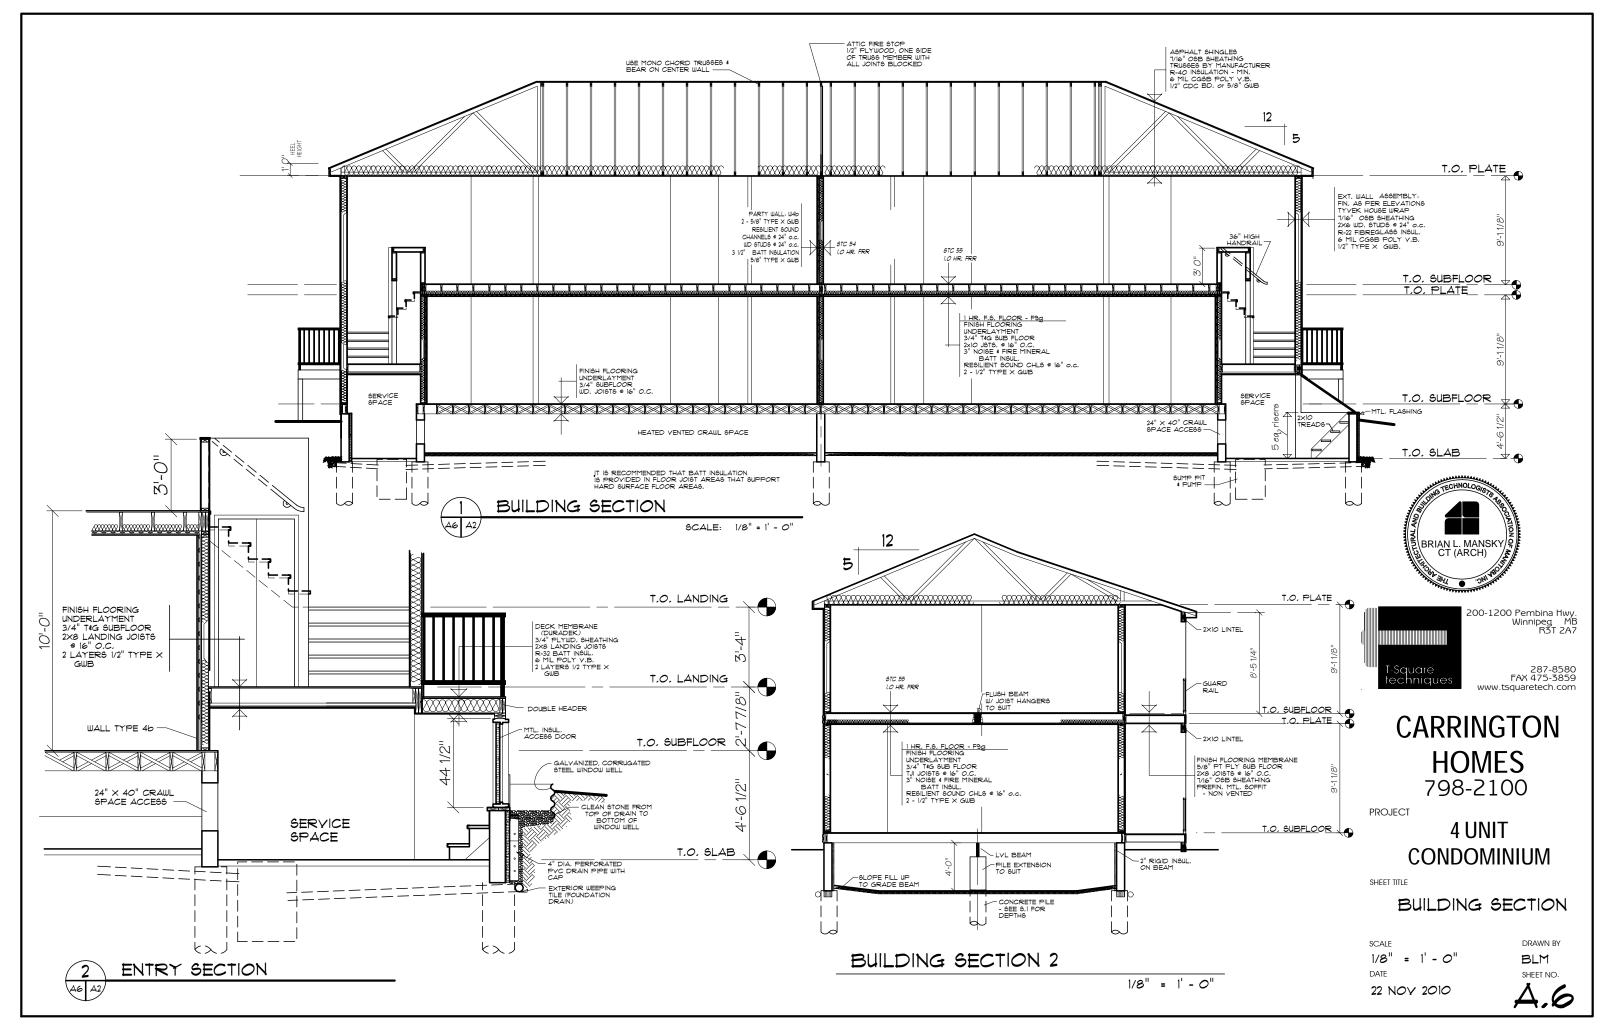

PILES NOTES 16" DIA, x 20' DEEP CONC, PILES C/W 1-25M YERT. - FOR DECKS & LANDINGS 16" DIA. x 25' DEEP CONC. PILES C/W 1-25M YERT. 24" DIA, × 30' DEEP C/W 1-25M YERT, 20" DIA, X 25' DEEP C/W 1 25M VERT. PILE DEPTHS SHOWN ARE ACTUAL DEPTH FROM GROUND SURFACE TO END OF PILE EXCLUSIVE OF ANY PILE EXTENSION MADE ABOVE GRADE LEYEL . REINFORCE ABOVE GRADE PORTIONS OF PILE EXTENSIONS WITH: 4-15M VERT, X 6' LONG 4-10M RINGS EQUALLY SPACED EXTEND PILE REINFORCING INTO GRADE BEAMS 18" AND HOOK INTO GRADE BEAM REINFORCING. PROVIDE 5' - O" OF GREASED SONO-TUBE AT THE TOP OF EACH BALCONY PILE INDICATED * 91'-8" 12'-0" 11'-6" 11'-0'' 11'-4" 11'-4" 11'-0" 11'-6" 12'-0" **FROVICH** B (51 | 52) 24 x 32" CRAWL SPACE ACCESS REINFORCED CONCRETE 24 x 32" CRAWL SPACE ACCESS **& ASSOCIATES** 2X10 * 2 6PF JOISTS 16"o.c. ABOVE typical GRADE BEAM STRUCTURAL ENGINEERS 3" CONC. SLAB. 120 ST. ANNE'S ROAD WINNIPEG MANITOBA 204.254.0666 FAX 256.8379 8" × 48" - 4" DIA, NON-PERFORATED LEADER PIPE A 50 3'-10" SI 52 200-1200 Pembina Hwy. Winnipeg MB R3T 2A7 Ú MIN, SLOPE 1:50 TO SUMP PIT الما 8'-5' 8'-5" A 51 52 2 ply 14" LVL BEAM 2 ply 14" LVL BEAM T-Square techniques 287-8580 FAX 475-3859 _____ _____ 12'-4" 16'-10" 17'-0" 12'-8" 12'-6" 12'-8" **CARRINGTON** 4 3/4" 8" × 24" CONC. **HOMES** GR. BEAM. 14'-10 -10 <u>7</u> 8'-0" 14'-4" 11'-8" 8'-0" 8'-0" 11'-8'' 14'-4" 8'-0" 798-2100 **PROJECT** 3-2×10 #2 SPF BEAM 3-2×10 #2 SPF BEAM 4 UNIT **CONDOMINIUM** PROVINCE OF MANIFOR SHEET TITLE $\dot{\Omega}$ FOUNDATION PLAN D 11'-0 1/2" L.E. S1 S2 15'-0" 5'-0" 39'-0" 5'-0" 5'-0" 15'-0" DRAWN BY FROVICH 84'-0" 1/8" = 1' - 0" BLM DATE SHEET NO. PROFESSIONAL S. 22 NOY 2010

GENERAL NOTES

CONCRETE NOTES

- , CONCRETE STRENGTH AT 28 DAYS SHALL BE 25 MPA FOR ALL CAST-IN-PLACE CONCRETE, 2. REINFORCING STEEL SHALL BE NEW BILLET GRADE 400 DEFORMED BARS WITH A MINIMUM
- YIELD STRENGTH OF 400 MPA FOR SIZE #20 AND LARGER AND GRADE 300 DEFORMED BARS WITH A MINIMUM YIELD STRENGTH OF 300 MPA FOR SIZE *15 AND SMALLER ACCORDING TO THE CURRENT EDITION OF C.S.A. STANDARD G 30, 12, ALL REINFORCEMENT SHALL BE FREE OF LOOSE RUST, MUD, OIL OR OTHER COATINGS THAT WOULD REDUCE THE CONCRETE BOND.
- 3. REINFORCING STEEL SHALL BE DETAILED IN ACCORDANCE WITH THE CURRENT EDITION OF C.S.A. STANDARD A 23.
- 4. PROVIDE A MINIMUM 24 BAR DIAMETER LAP OF ALL HORIZONTAL REINFORCING BARS AT THE CORNERS OF WALLS AND BEAMS.
- 5. PROVIDE 150 mm VOID FORM UNDER ALL WALLS AND BEAMS LESS THAN 1200 mm BELOW EXISTING OR FINISHED GRADE.
- 6. DURING COLD WEATHER CONSTRUCTION (I.E. AVERAGE AMBIENT DAILY TEMPERATURE BELOW 5 DEGREES CELSIUS) ADEQUATE HOARDING AND HEATING SHALL BE PROVIDED TO MAINTAIN THE FOLLOWING TEMPERATURES FOR THE GIVEN DURATION OF TIME FOR NORMAL PORTLAND CEMENT CONCRETE.

DURATION 1 DAYS TEMPERATURE 10 DEGREES C 20 DEGREES C 3 DAYS

AFTER THE CONCRETE TEMPERATURE HAS BEEN MAINTAINED AS OUTLINED ABOVE THE TEMPERATURE SHALL BE MAINTAINED AT 5 DEGREES CELSIUS FOR 4 ADDITIONAL DAYS, WHEN THE HEAT IS REMOVED, THE CONCRETE TEMPERATURE WILL NOT BE ALLOWED TO

DROP MORE THAN 5 DEGREES CELSIUS IN ANY 24 HOUR PERIOD. 7. CALCIUM CHLORIDE SHALL NOT BE USED AS A CONCRETE ADDITIVE UNDER ANY CIRCUMSTANCES.

WOOD NOTES


- I. ALL STRUCTURAL SAWN LUMBER USED FOR POSTS, STUDS, JOISTS, RAFTERS AND BUILT-UP BEAMS SHALL BE SPECIES GROUP "D", STRESS GRADE NO. "2", NOR MORE THAN 15 PERCENT OF THE LUMBER SUPPLIED SHALL BE OF A GRADE LOWER THAN SPECIFIED.
- 2. ALL STRUCTURAL SAWN LUMBER SHALL BE IN ACCORDANCE WITH THE REQUIREMENTS OF C.S.A. STANDARD 086 AND THE REQUIREMENTS OF THE CURRENT EDITION OF THE NATIONAL BUILDING CODE OF CANADA.
- 3. PROVIDE DOUBLE JOISTS UNDER ALL PARTITIONS THAT RUN PARALLEL TO THE JOISTS
- 4. PROVIDE BRIDGING AS DETAILED ON THE FLOOR JOIST SUPPLIERS SHOP DRAWINGS.
 5. ALL FLUSH FRAMED BEAM JOIST CONNECTIONS SHALL USE JOIST HANGERS.
 6. ROOF TRUSS MANUFACTURER SHALL PROVIDE THE ENGINEER WITH LINTEL, BRACING, AND REINFORCING DETAILS OF THE ERECTION OF ALL FLOOR AND ROOF TRUSSES OVER 45'-0" IN LENGTH.
- 1. TRUSS MANUFACTURER SHALL DETAIL AND PROVIDE NECESSARY CONNECTION HARDWARE FOR ALL FLUSH FRAME TRUSSES.
- 8, LAMINATED VENEER LUMBER AND FABRICATED WOOD STRUCTURAL ELEMENTS SHALL BE DESIGNED TO CARRY THE NOTED APPLIED LOADS AND MEET THE REQUIREMENTS OF C.S.A. STANDARD 086 C.S.A. STANDARD 0141 AND THE REQUIREMENTS OF SPECIAL INVESTIGATIVE REPORT * LO 4000-419.
- 9. PROVIDE BRIDGING AND BLOCKING BETWEEN FABRICATED ROOF AND FLOOR JOISTS ACCORDING TO THE MANUFACTURERS SHOP DRAWINGS AND DETAILS.

 10. FABRICATED WOOD STRUCTURAL ELEMENT SUPPLIER SHALL DESIGN AND SUPPLY ALL
- CONNECTION MATERIAL REQUIRED FOR CONNECTIONS OF FABRICATED ELEMENTS TO CONCRETE, DIMENSION LUMBER ECT. WHERE CONNECTIONS ARE NOT DETAILED IN PART 9 OF NBCC
- II, ROOF TRUSS FRAMING TO BE DESIGNED BY THE PREFABRICATED ROOF TRUSS SUPPLIER. ALL TRUSS FRAMING SHALL BE DESIGNED TO BE SELF SUPPORTING TO THE EXTERIOR BUILDING WALLS UNLESS NOTED OTHERWISE, GIRDER TRUSS LOCATIONS TO BE DETERMINED BY TRUSS SUPPLIER, TRUSS SUPPLIER TO PROVIDE ERECTION DRAWINGS SHOWING ALL PERMANENT BRIDGING AND TEMPORARY ERECTION BRACING LOCATIONS.
- 12. ROOF TRUSS SUPPLIER TO DESIGN AND SUPPLY ALL CONNECTION MATERIAL FOR FLUSH FRAME TRUSS CONNECTIONS.
- 13. PROVIDE FULL BEARING FOR GIRDER TRUSSES IN WALL CONSTRUCTION AT GIRDER TRUSS LOCATIONS, FRAMING TO BE CONTINUOUS TO FOUNDATION ELEMENTS.

DESIGN NOTES

AS SPECIFIED BY NBCC (05) FOR THE WINNIPEG, MB AREA	36	P5F
FLOOR LIVE LOADS A) RESIDENTIAL AREAS AND RELATED BALCONIES	40	PSF
ALL AREAS - DESIGN DEAD LOAD	15 1	PSF
PILE SKIN ERICTION VALUE3	300	PSF



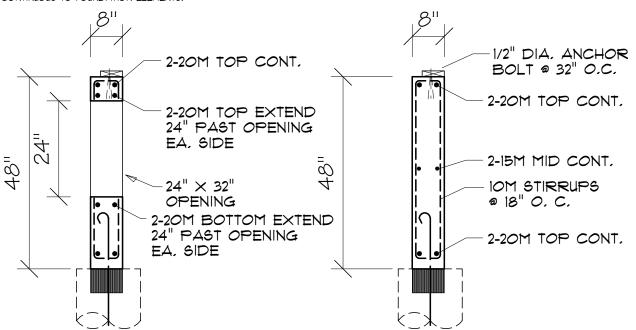

& ASSOCIATES STRUCTURAL ENGINEERS

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CARRINGTON HOMES 798-2100

PROJECT

4 UNIT **CONDOMINIUM**


SHEET TITLE

GRADE BEAM DETAILS

DRAWN BY BLM SHEET NO.

5.2

22 NOV 2010

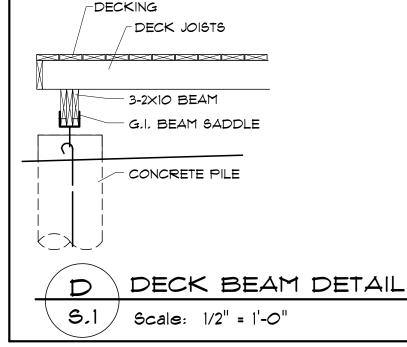

SERVICE AREA BEAM W/ OPENING 5.1 Scale: 1/2" = 1'-0'

5.1

SERVICE AREA GRADE BEAM DETAIL

Scale: 1/2" = 1'-0'

8'-11/2" 67'-9" 8'-1 1/2" 2'-4 1/2" 5'-4" 52'-4 1/2" 5'-4" 2'-4 1/2" 12'-5 1/4" 15'-6 3/4' 5'-0 44'-0" DECK JOISTS - 2X8" #2 SPF @ 16" O.C. 15'-0" 15'-0"

34'-0"

84'-0"

5'-0''

5'-0''



- -JOISTS ARE 2XIO #2 SPF @ IG" O.C. UNLESS OTHERWISE NOTED.
- -DECK JOISTS ARE 2x8 #2 SPF @ 16" o.c. UNLESS OTHERWISE NOTED.
- -PROVIDE JOIST HANGERS TO SUIT AT ALL FLUSH FRAMED CONDITIONS.
- FLOOR BEAMS ARE SUPPORTED ON CONCRETE GRADE BEAMS OR CONCRETE PILES AT THIS LEVEL,



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SHEET TITLE

MAIN FLOOR JOIST LAYOUT

SCALE 1/8" = 1' - 0" DATE

DRAWN BY BLM SHEET NO.

22 NOY 2010

5.3

5'-0"

5'-0"



- -THIS DRAWING IS INTENDED TO LOCATE FLOOR OPENINGS, RECESSES AND CANTILEVERS.
- -JOISTS ARE 2XIO #2 SPF @ 16" O.C. UNLESS OTHERWISE NOTED.
- -DECK JOISTS ARE 2x8 *2 SPF @16" o.c. UNLESS OTHERWISE NOTED.
- -PROVIDE JOIST HANGERS TO SUIT AT ALL FLUSH FRAMED CONDITIONS.

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CARRINGTON **HOMES**

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PROJECT

4 UNIT **CONDOMINIUM**

SECOND FLOOR JOISTS


SCALE

DRAWN BY BLM

22 NOY 2010

1/8" = 1' - 0" DATE

SHEET NO.

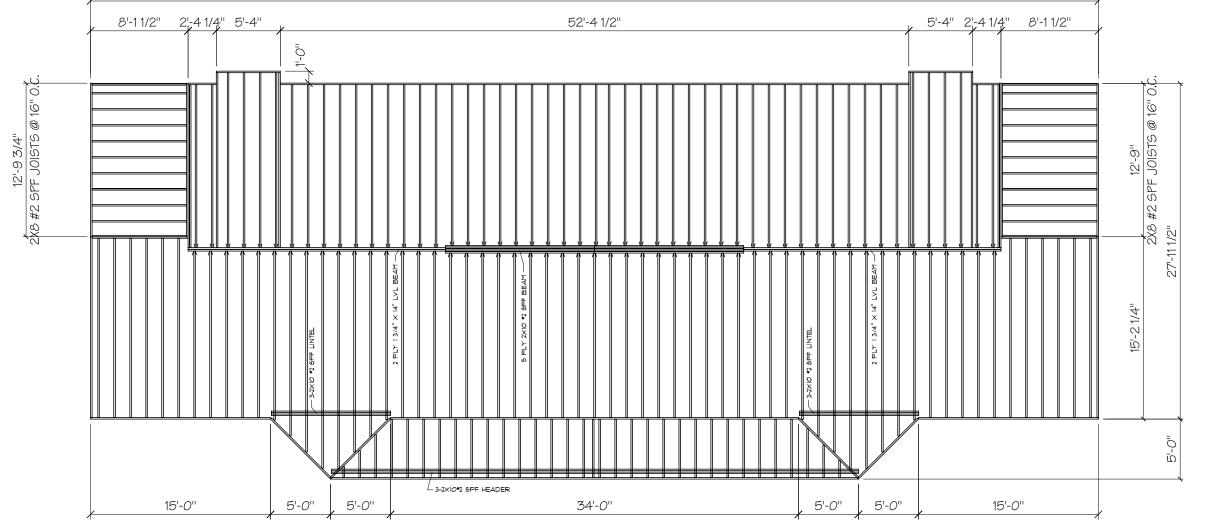

84'-0"

SECOND FLOOR JOIST LAYOUT

SCALE: 1/8" = 1'0"